

GUELPH/ERAMOSA TOWNSHIP NEW SIGNAGE

VARIOUS LOCATIONS ONTARIO

ISSUED FOR TENDER
JUNE, 2023
_____SET NO.

001


DRAWING LIST


DRAWING	ARCHITECTURAL DRAWINGS TITLE	DRAWING	ELECTRICAL DRAWINGS	DRAWING	DRAWING	DRAWING	DRAWING	DRAWING	DRAWING
REF.		REF.	TITLE	REF.	TITLE	REF.	TITLE	REF.	TITLE
A-1 A-2 A-3 A-4 A-5 A-6 A-7 A-8	COVER PAGE GIGN FRONT & REAR ELEVATION GIGN SIDE ELEVATIONS GIGN SECTION DETAILS GIGN PLAN DETAILS GITE #1 - 8348 WELLINGTON RD 124 GITE #2 - 5141 WELLINGTON RD 27 GITE #3 - 330 ALMA ST, ROCKWOOD GITE #4 - 127 DUNBAR ST, ROCKWOOD GITE #5 - 7384 WELLINGTON RD 30	E-102 EL E-103 EL E-104 EL	EC. PLANS 8348 WELLINGTON RD 124 EC. PLANS 5141 WELLINGTON RD 27 EC. PLANS 330 ALMA ST, ROCKWOOD EC. PLANS 127 DUNBAR ST, ROCKWOOD EC. PLANS 7384 WELLINGTON RD 30						










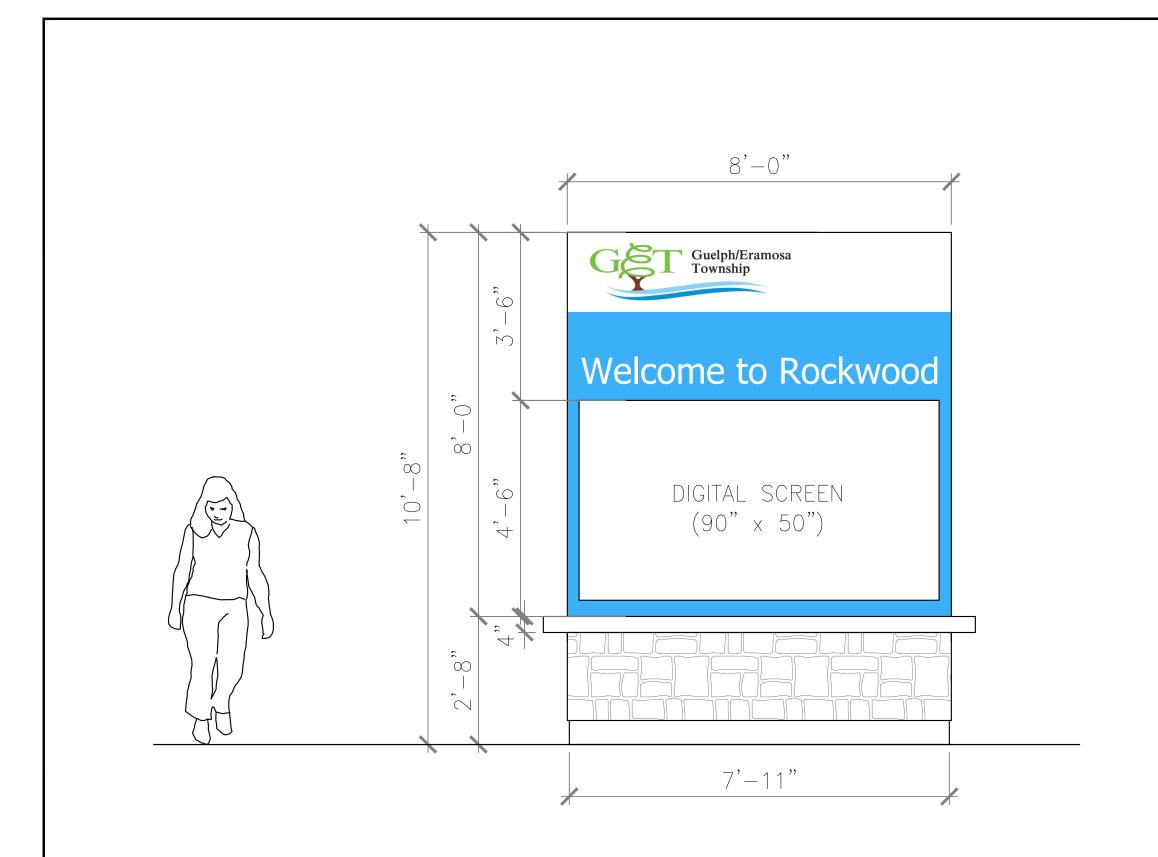

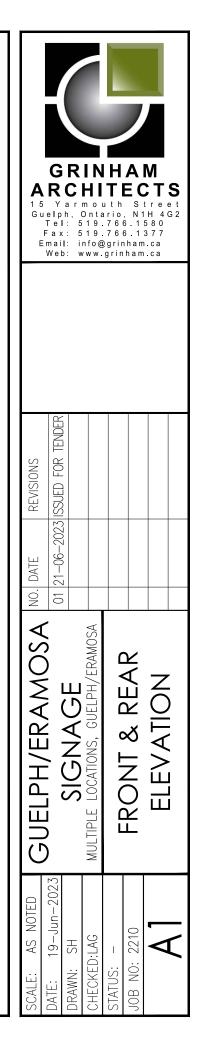


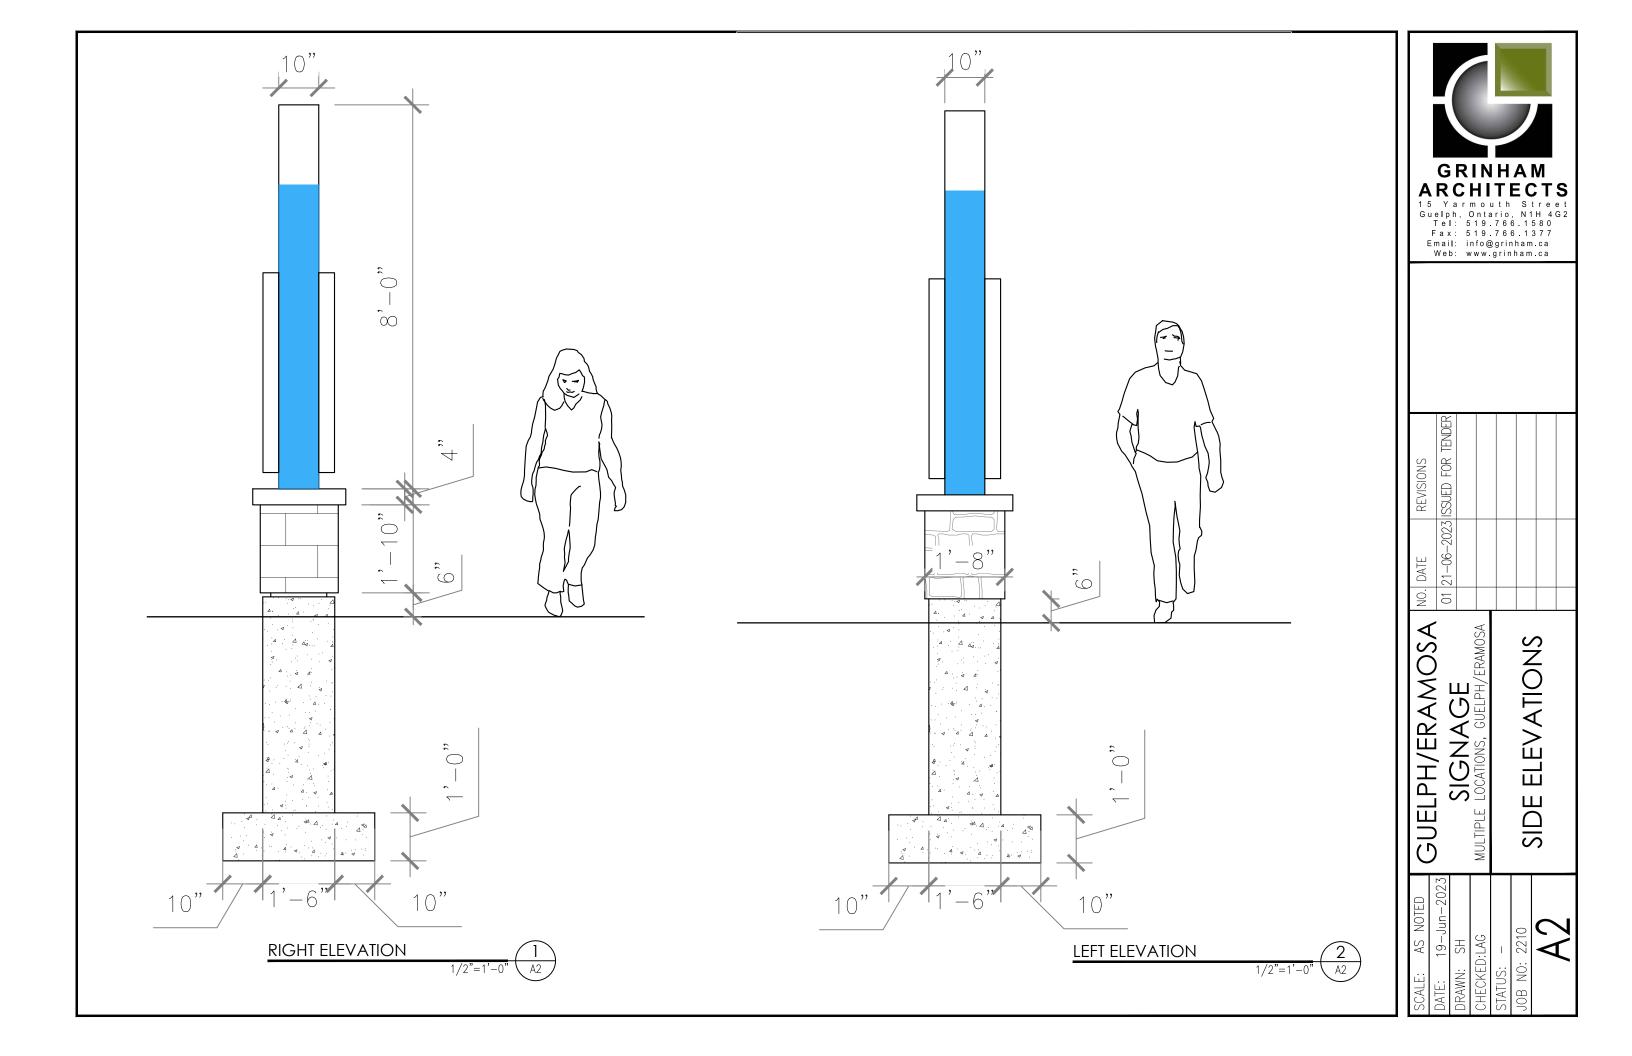


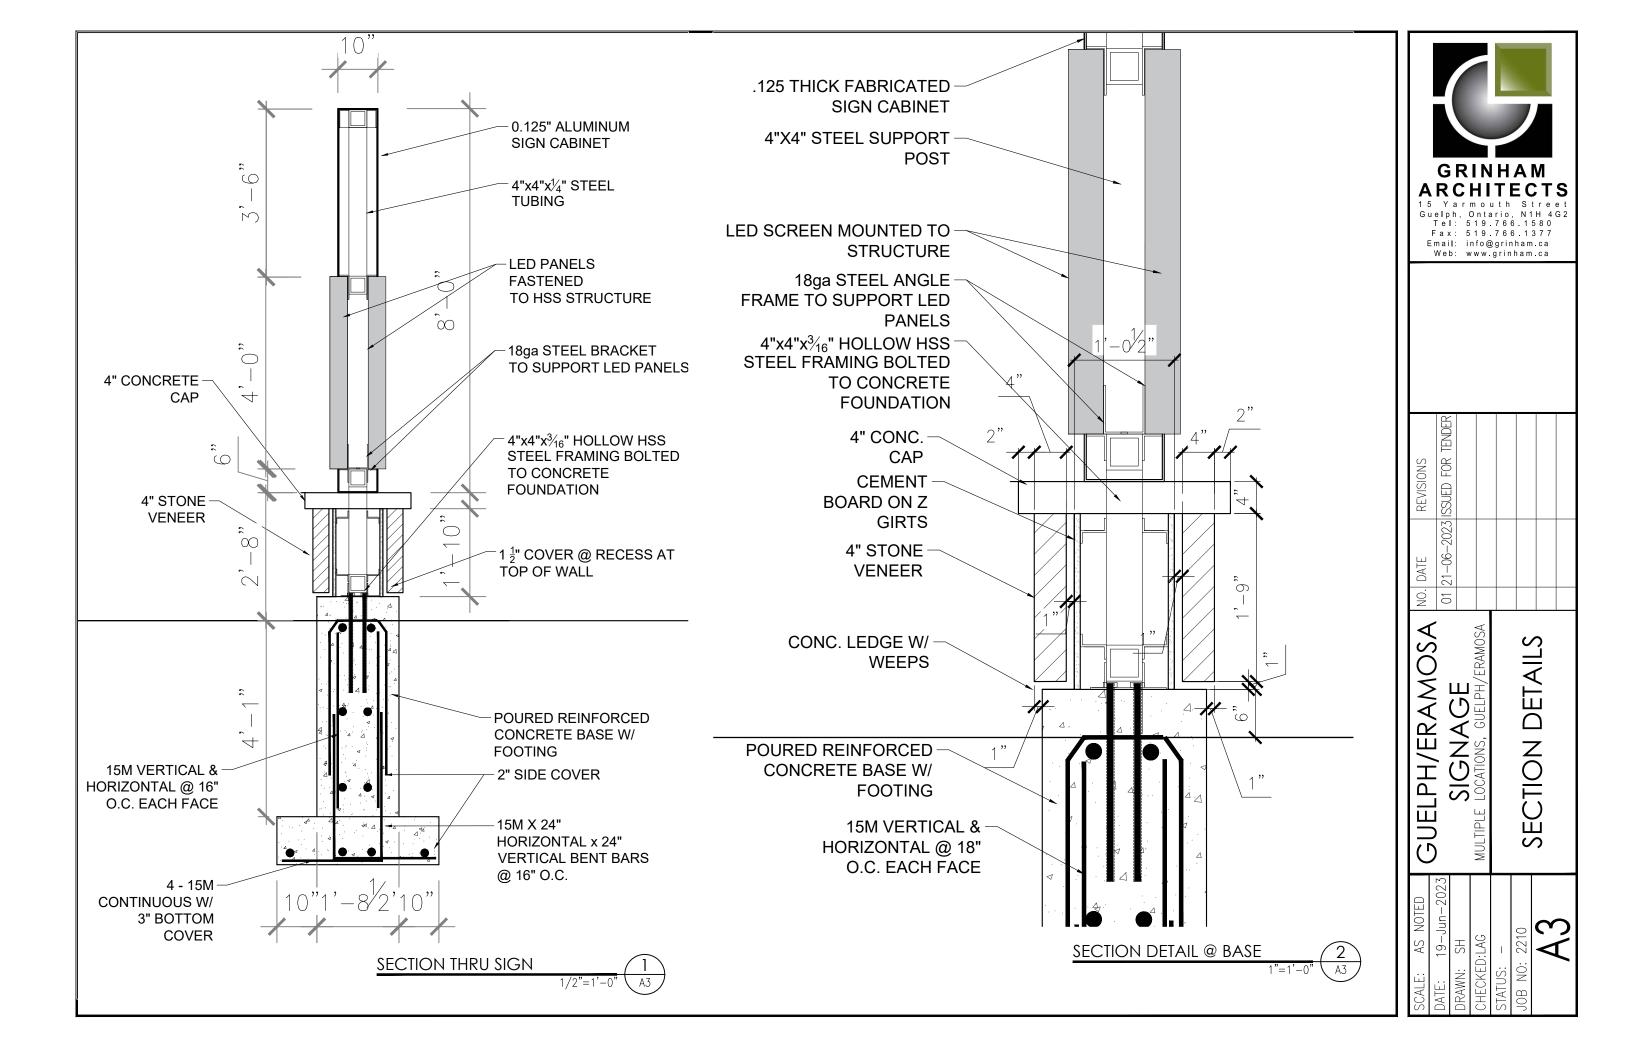


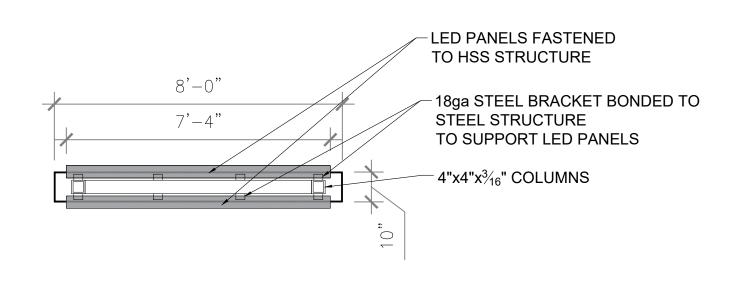





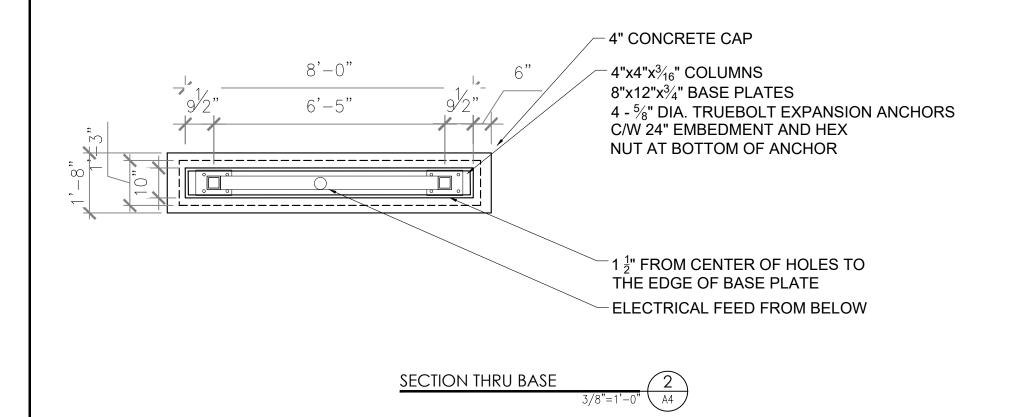

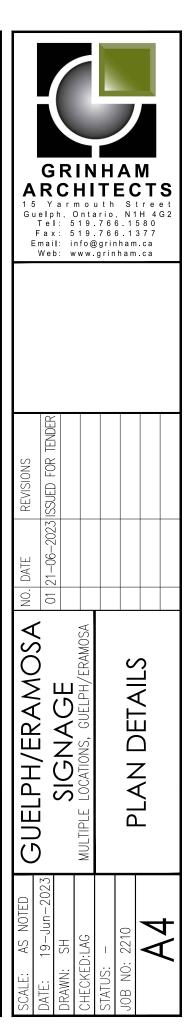


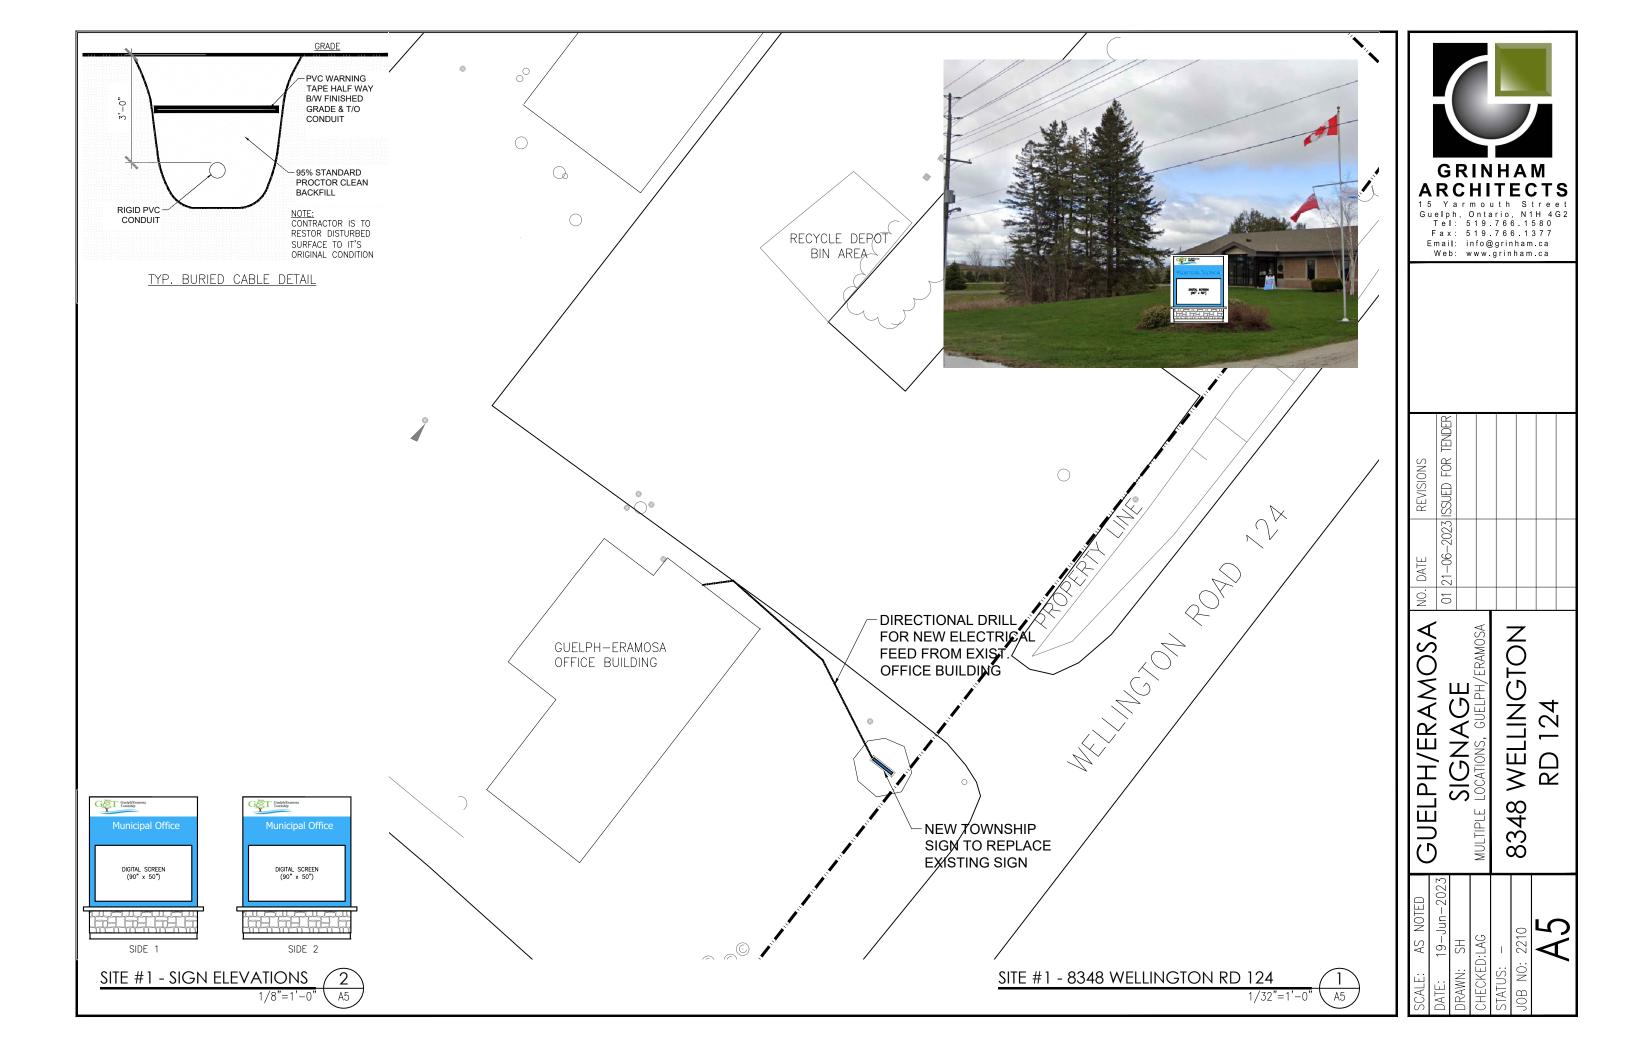


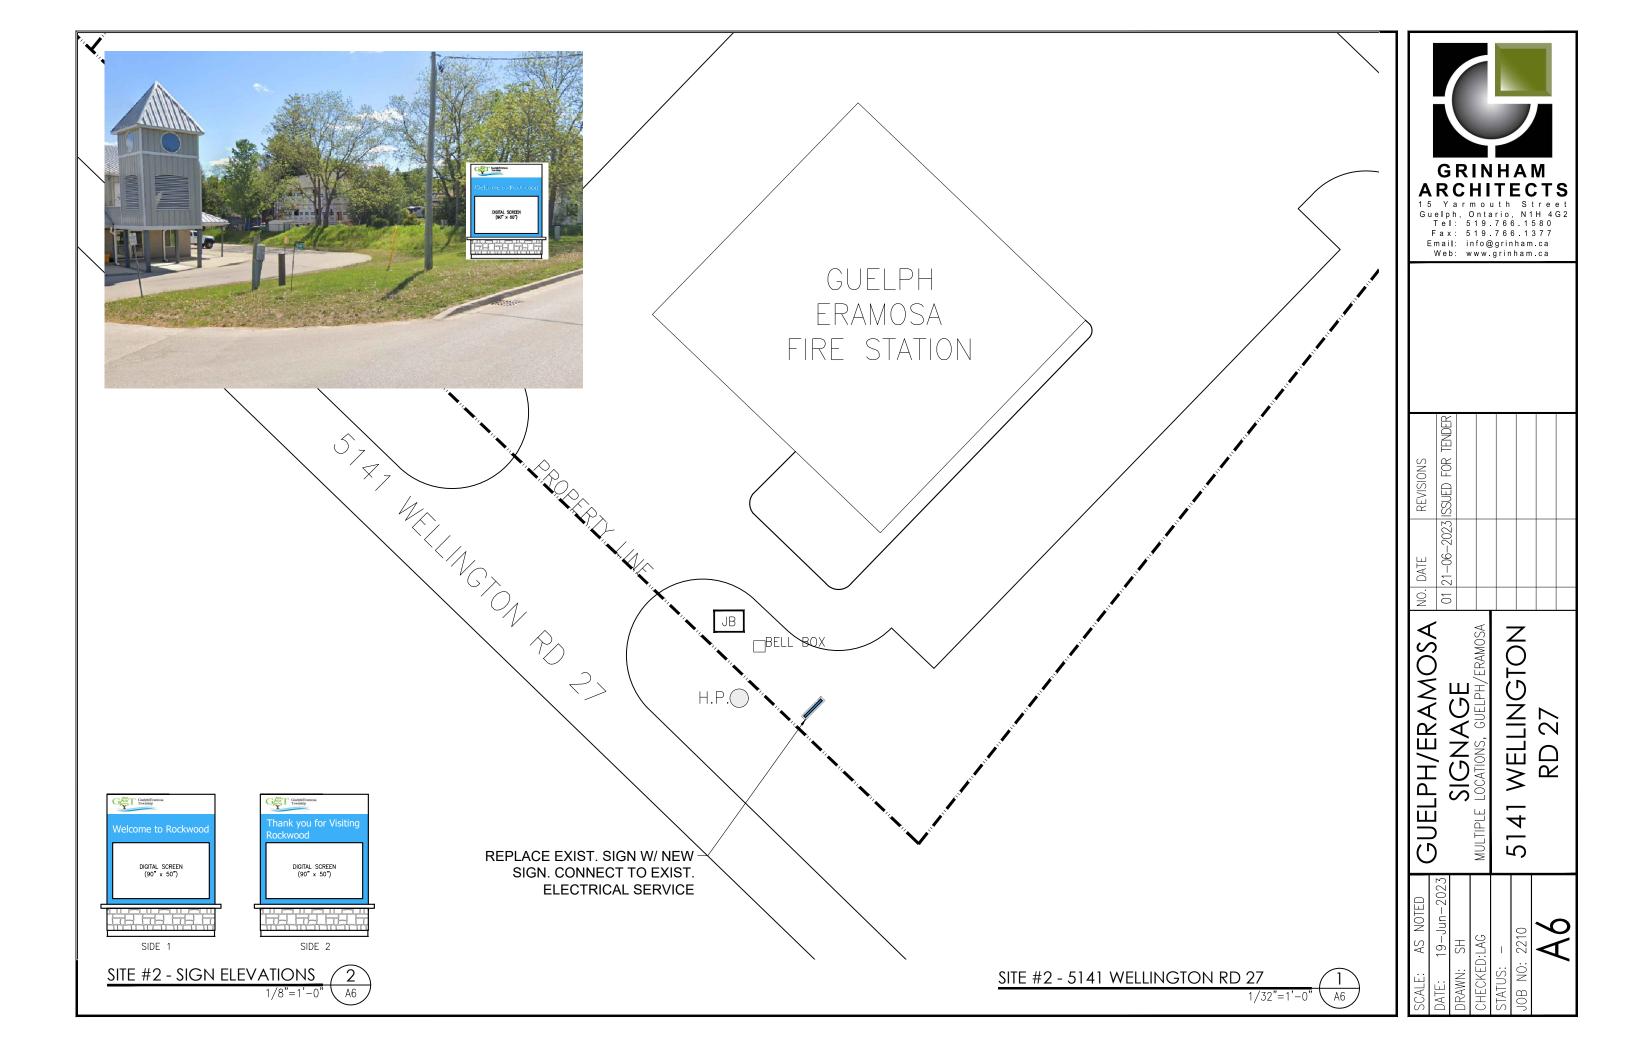


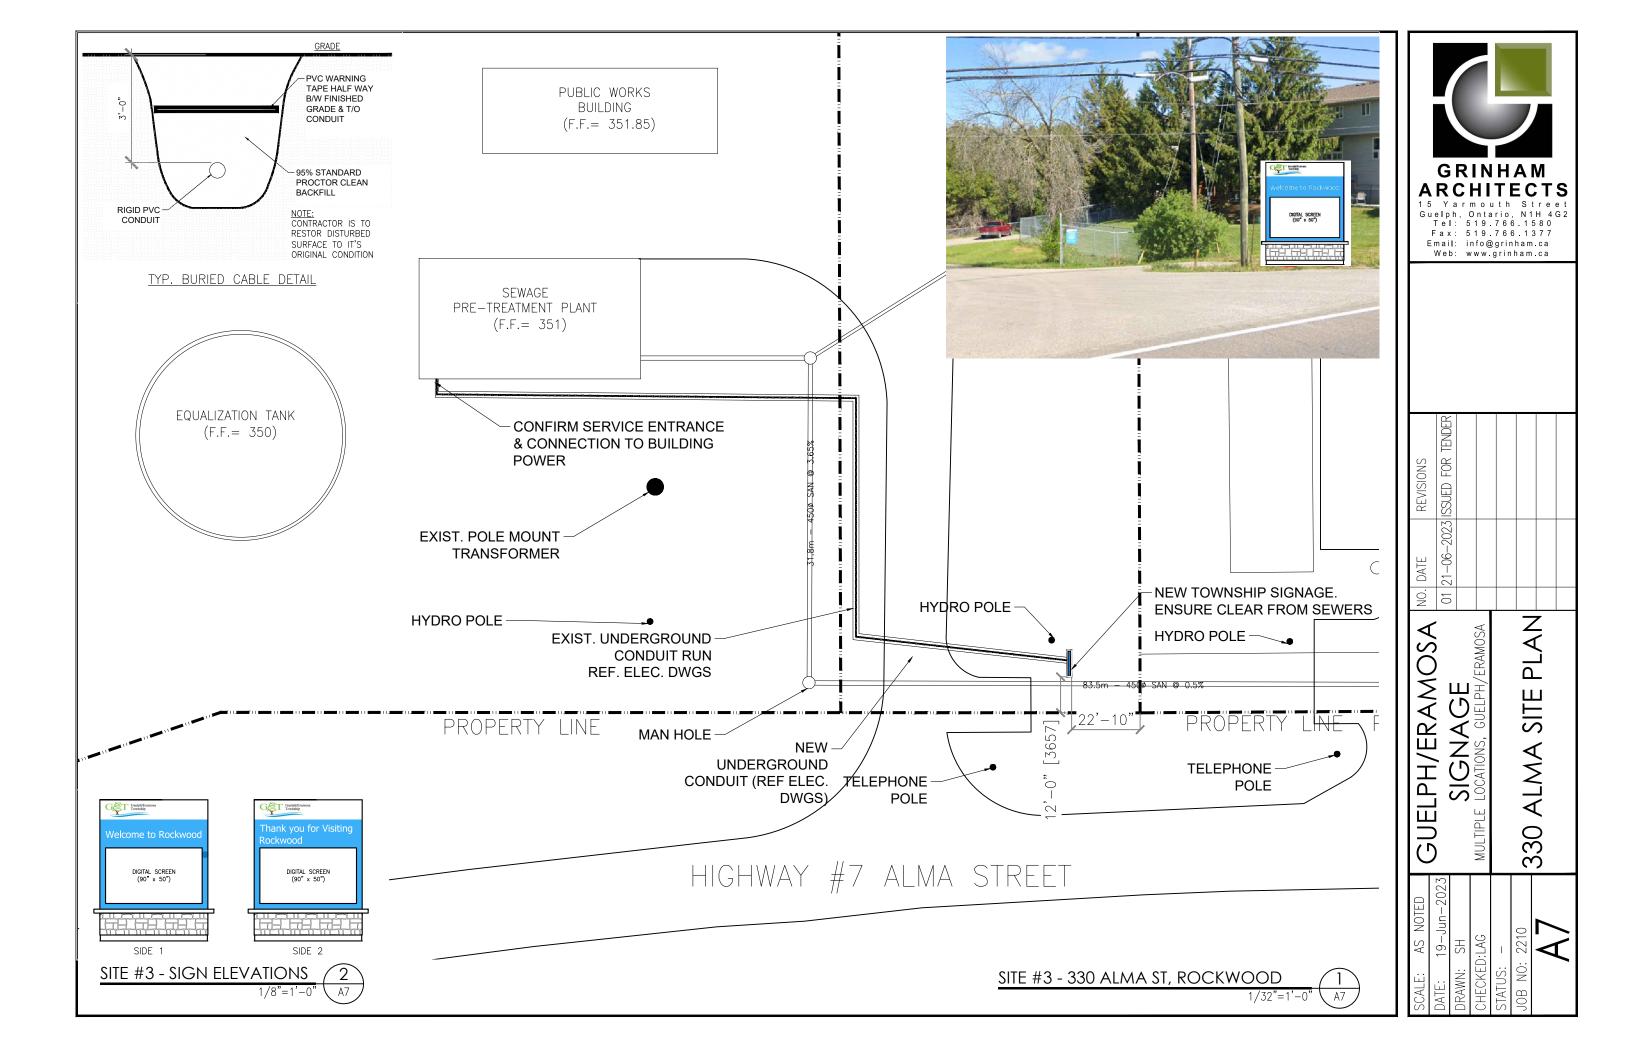



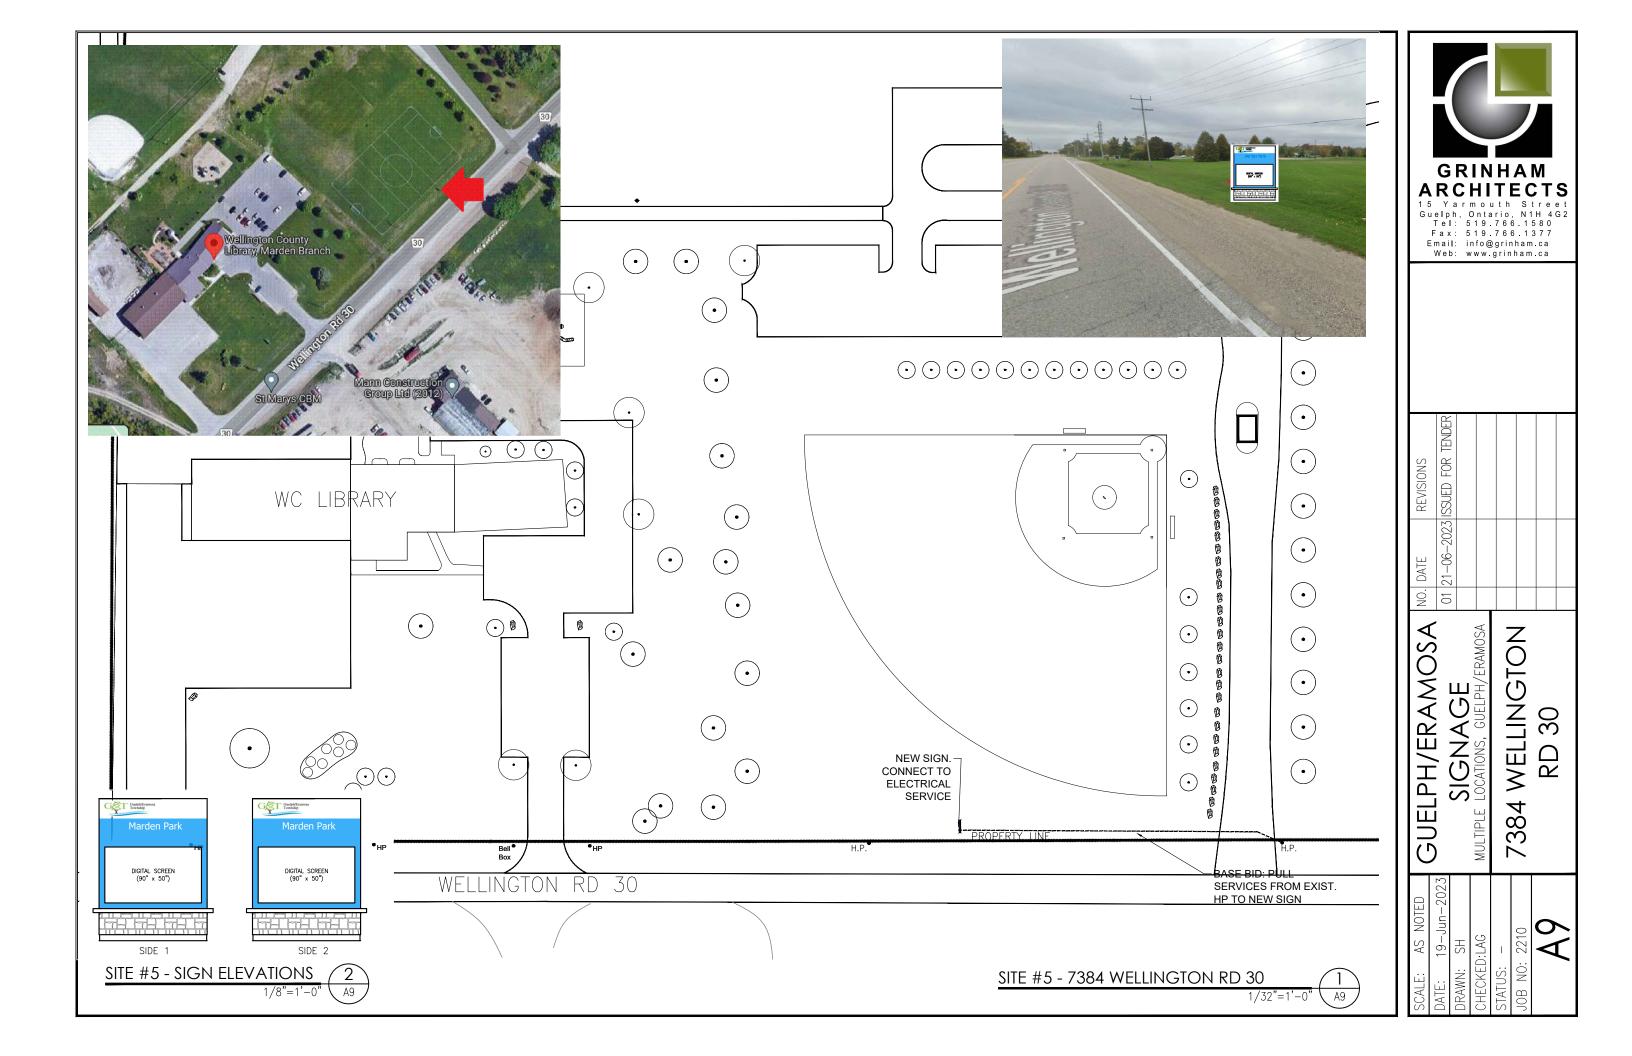


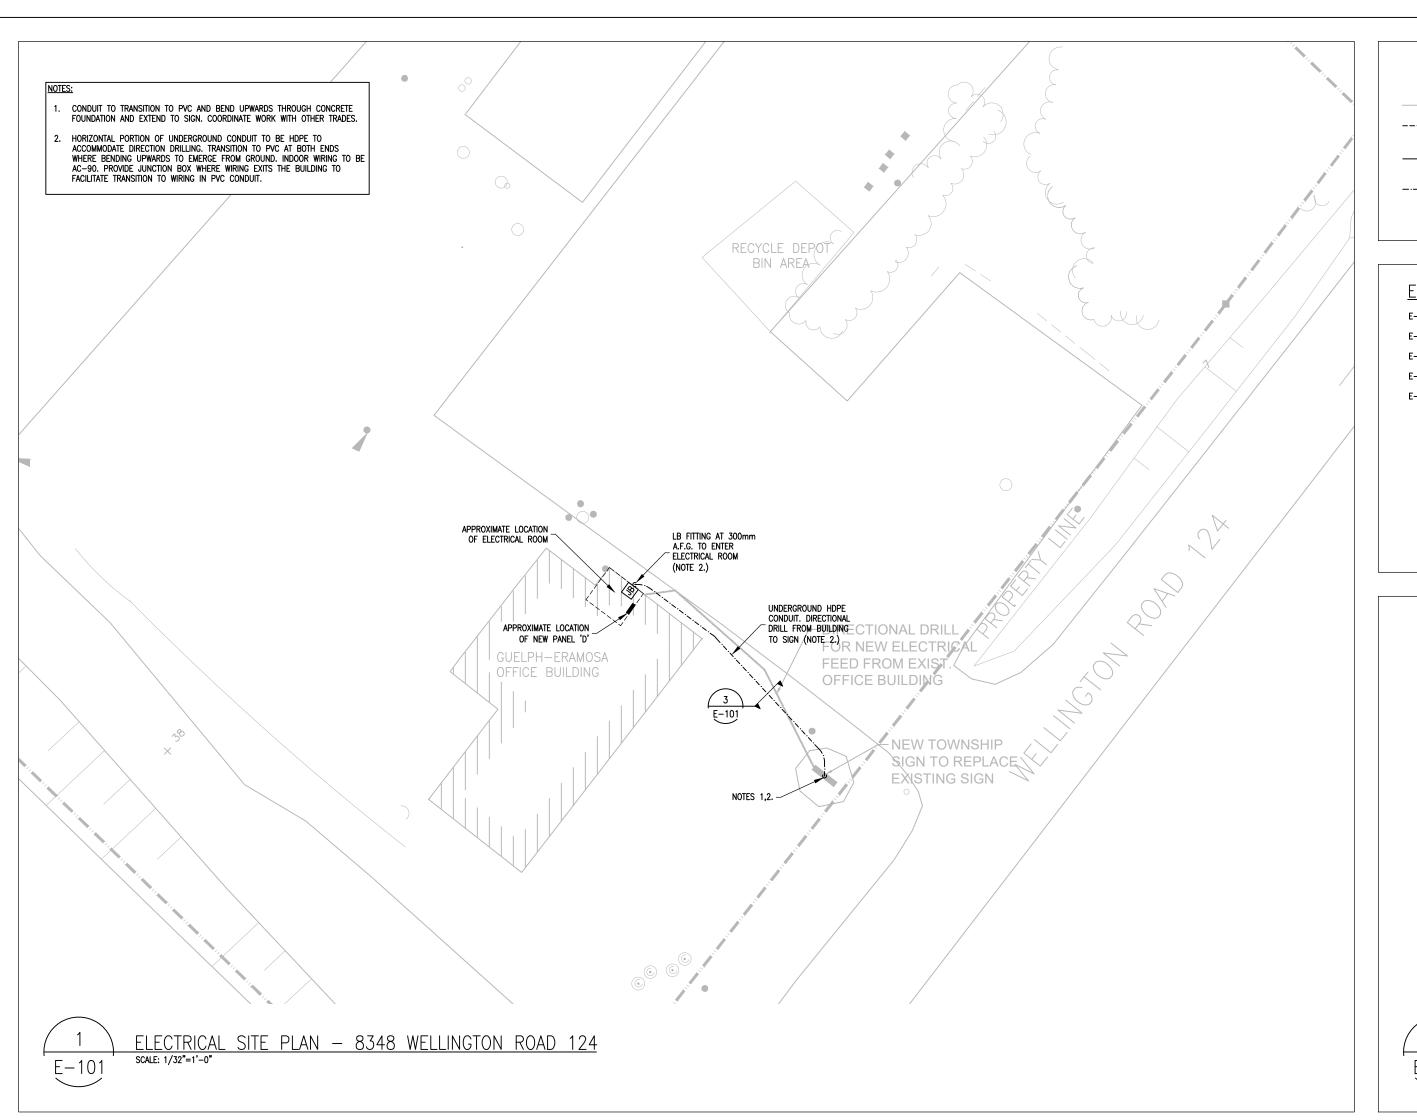


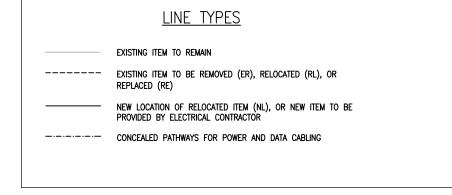

ELECTRICAL DRAWING LIST

- E-101: ELECTRICAL PLANS 8348 WELLINGTON ROAD 124 E-102: ELECTRICAL PLANS - 5141 WELLINGTON ROAD 27
- E-103: ELECTRICAL PLANS 330 ALMA STREET E-104: ELECTRICAL PLANS - 127 DUNBAR STREET
- E-105: ELECTRICAL PLANS 7384 WELLINGTON RD 30

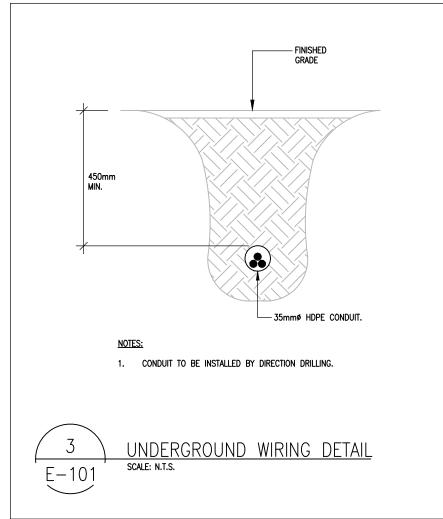


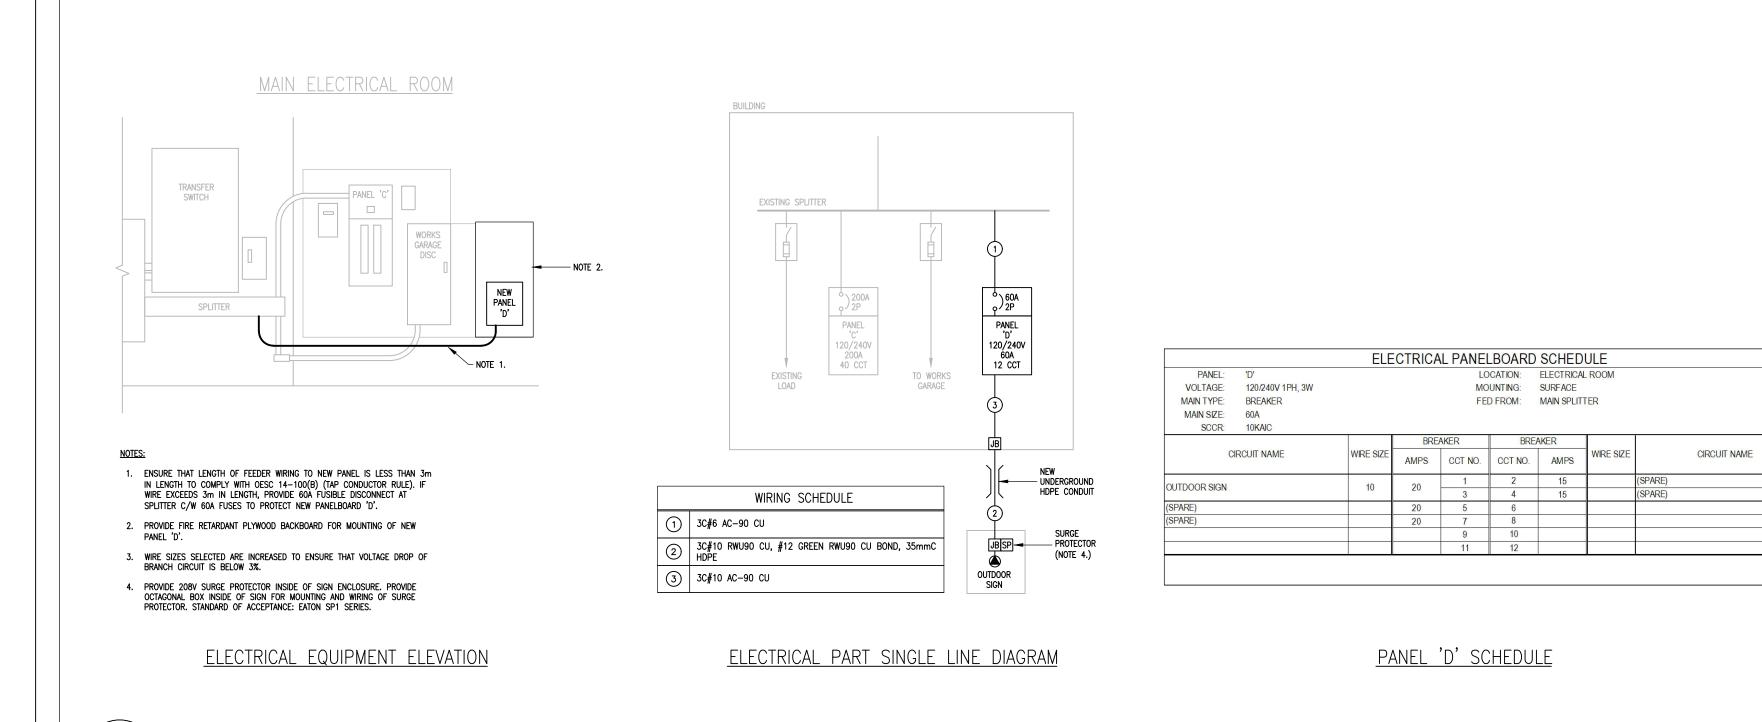

ELECTRICAL POWER PLAN — RENOVATION

ELECTRICAL SYMBOLS <u>LEGEND</u>

- JB ELECTRICAL BOX: JB JUNCTION BOX PB PULL BOX r☑ - DISCONNECT SWITCH, FUSED
- DIRECT CONNECTION TO EQUIPMENT UTILITY METER SOCKET C/W MAIN BREAKER
- SP SURGE PROTECTOR

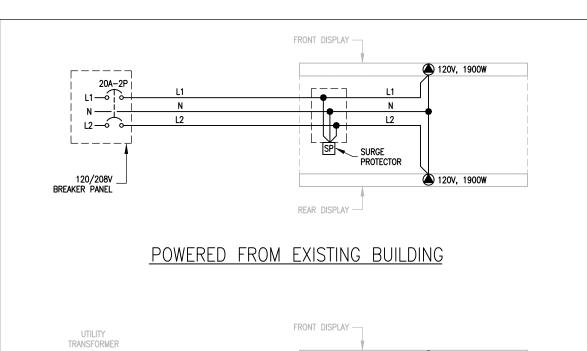

COMBINATION SERVICE SWITCH WITH METER — BASE BY CONTRACTOR REAR DISPLAY


POWERED FROM UTILITY SERVICE

CIRCUITS RUN TO EACH SIGN TO INCORPORATE A SHARED NEUTRAL TO MINIMIZE VOLTAGE DROP.

TYPICAL SIGN POWER CONNECTION SCHEMATICS


GENERAL NOTES

- DO NOT RELY UPON INFORMATION SHOWN ON THIS DRAWING FOR CONSTRUCTION UNLESS IT STATES BELOW THE SHEET HAS BEEN SPECIFICALLY ISSUED FOR THAT PURPOSE AND THE SHEET HAS BEEN STAMPED AND SIGNED.
- DO NOT SCALE FROM DRAWINGS. PORTIONS OF DRAWINGS MAY NOT BE DRAWN TO
- 3. VERIFY ALL DIMENSIONS ON SITE BEFORE PROCEEDING WITH THE WORK. 4. COPYRIGHT 2023 JTECH CONSULTING.

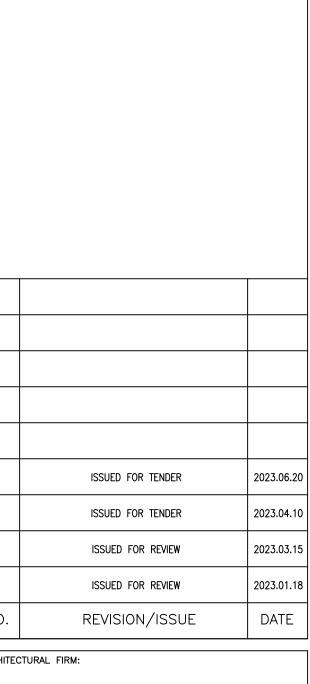

ARCHITECTURAL FIRM:



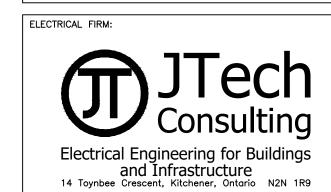

ENGINEERING SEAL:




PROJECT NAME AND ADDRESS:

GUELPH/ERAMOSA SIGNAGÉ PROJECT (VARIOUS SITES)

DRAWING TITLE:

ELECTRICAL PLANS 8348 WELLINGTON ROAD 124

PROJECT NO:	SHEET:
JT230012	
DATE: 2023.01.03	E-101
SCALE: $1/32" = 1'-0"$	

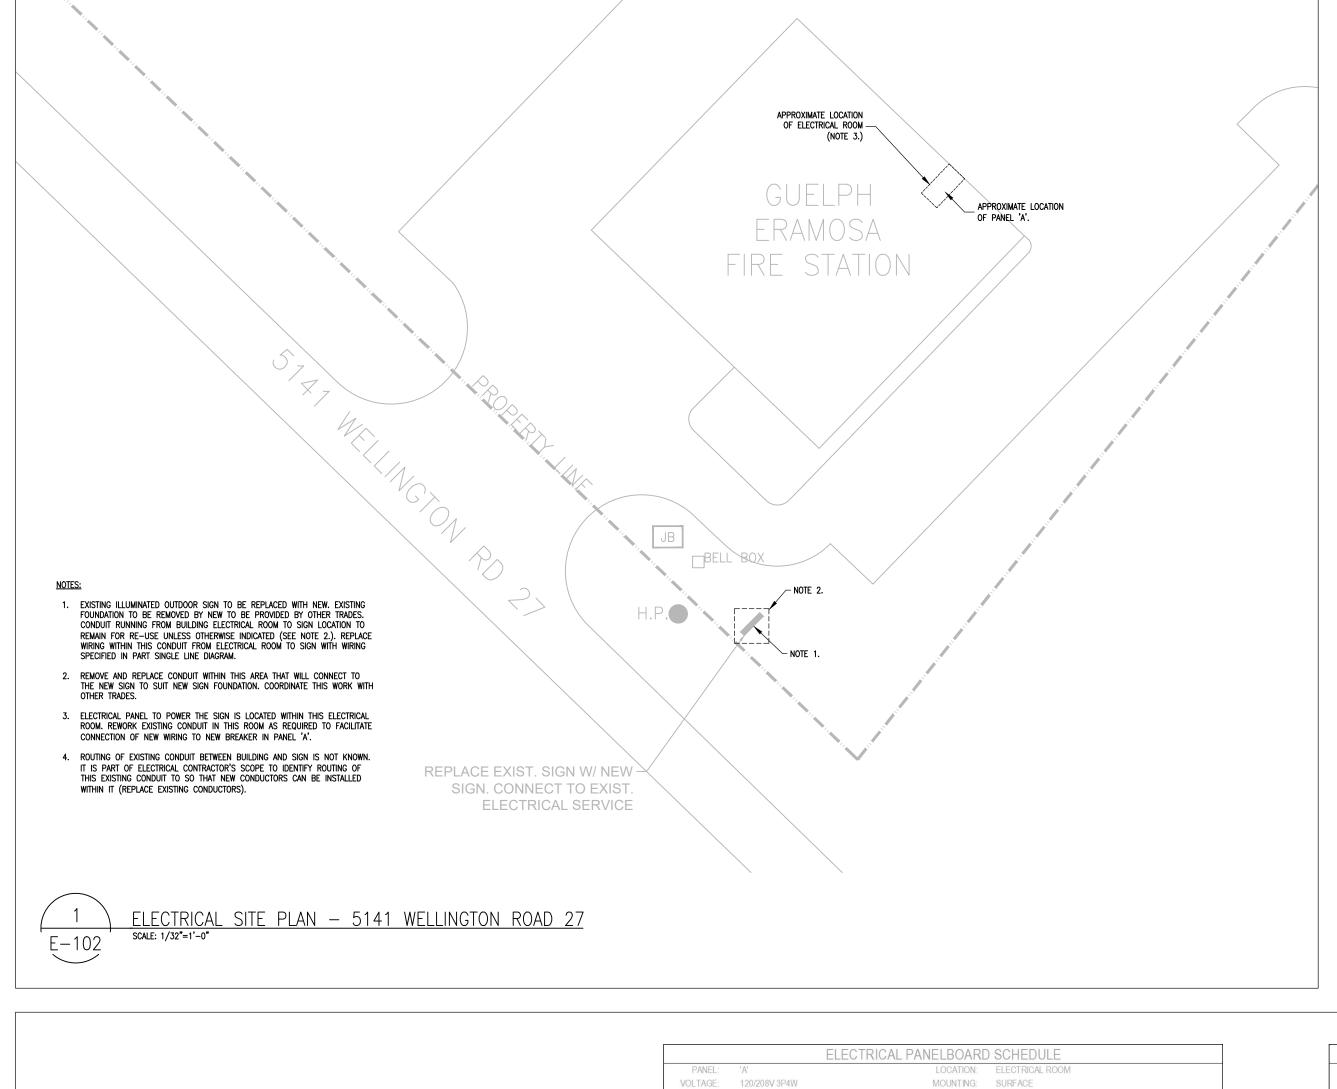

PANEL: 'A'		LC	CATION:	L ROOM		
VOLTAGE: 120/208V 3P4W		MO	UNTING:	SURFACE		
MAIN TYPE: M.L.O.		FEI	D FROM:			
MAIN SIZE: 225A		MAKE	/MODEL:	SIEMENS T	YPE S3	
	BRE	AKER	BRE	AKER		
CIRCUIT TITLE	AMPS	CCT NO.	CCT NO.	AMPS	CIRCUIT TITLE	
OD/FAN (RANGE)	15	1	2	40	RANGE	
TCHEN GFCI	20	3	4	40	RANGE	
AINING RM TV (REAR)	15	5	6	50	DISHWASHER	
RIDGE REC.	15	7	8	50	DISHWASHER	
CHEN GFCI	20	9	10	15	GFCI REC - UPSTAIRES W/R	
CHEN GFCI	20	11	12	20	TRAINING RM LTG	
HEATERS (UPSTAIRS W/R)	15	13	14	15	FUTURE RM LTG	
TURE RM REC.	15	15	16	15	KITCHEN, BATH LTG	
TURE RM REC.	15	17	18	15	FIRE PREVENTION OFFICES LTG	
RM REC.	15	19	20	15	TRAINING OFFICES LTG	
AINING OFFICE, MECH RM REC.	15	21	22	15	TRAINING, COMMUNITY RM REC.	
RE PREVENTION REC.	15	23	24	15	TRAINING, COMMUNITY RM REC.	
RNACE	15	25	26	20	STAIR 13 FF HEATER	
COMP. 2ND FLOOR	50	27	28	15	HWT	
- COMMITTED TEORIT		29	30	15	FURNACE DOWN.	
		31	32	30	2ND FLOOR NETWORK CABINET	
	15	33	34	30	A/C MAIN FLOOR	
YER	20	35	36			
TDOOR SIGN POWER (NOTE 1.)	20	37	38	15	WASHER	
		39	40			
PACE)		41	42			
HEF DEA REC.	15	43	44	60	SIREN	
ONFERENCE REC.	15	45	46	00	SIRLIN	
YER REC.	15	47	48	15	ELECTRICAL RM	
APTAIN'S OFFICE REC.	15	49	50	15	GFCI FRONT ENTRANCE	
LL REC.	15	51	52	20	STAIR A HTR	
EN'S & WOMEN'S GFCI	15	53	54	20	VESTIBULE HTR	
ASHER	15	55	56	15	LAUNDRY RM/T.O. & SBCA LTG	
JDRY REC.	15	57	58	15	CORRIDOR LTG	
	15	59	60	15	WOMENS/MECH/CAPTAIN'S RM LTG	
	15	61	62	15	MEN'S W/R, CHIEF DEPUTY LTG	
EVATOR	15	63	64	15	HALL/POLICE/CONFERENCE LTG	
	10	65	66	15	DISPATCH/BF W/R LTG	
		67	68	15	SCBA/TURNOUT VENT FAN	
BA COMPRESSOR	40	69	70	15		
		71	72	20	E. BB HEATERS MEN'S/WOMEN'S	
PARE)	15	73	74	15	PARAMEDIC'S OFFICE REC.	
EVATOR CONTROL	15	75	76	15	DISPATCH REC.	
EVATOR RM LTG, REC.	15	77	78	15	B.F. WASHROOM REC.	
GHT LTG	15	79	80	15	ELEVATOR PIT CCT	
IT, EMERG LTG.	15	81	82	15	T.O. BUNKER REC.	
T. EMERG LTG.	15	83	84	15	DOOR OPENERS (WHEEL CHAIR)	

<u>PANEL 'A' SCHEDULE - REVISED</u>

2023.04.10 ISSUED FOR TENDER 2023.03.15 ISSUED FOR REVIEW 2023.01.18 ISSUED FOR REVIEW DATE NO. REVISION/ISSUE ARCHITECTURAL FIRM:

ISSUED FOR TENDER

2023.06.20


GENERAL NOTES

DO NOT RELY UPON INFORMATION SHOWN ON THIS DRAWING FOR CONSTRUCTION UNLESS IT STATES BELOW THE SHEET HAS BEEN SPECIFICALLY ISSUED FOR THAT PURPOSE AND THE SHEET HAS BEEN STAMPED AND SIGNED.


2. DO NOT SCALE FROM DRAWINGS. PORTIONS OF DRAWINGS MAY NOT BE DRAWN TO

3. VERIFY ALL DIMENSIONS ON SITE BEFORE PROCEEDING WITH THE WORK.

4. COPYRIGHT 2023 JTECH CONSULTING.

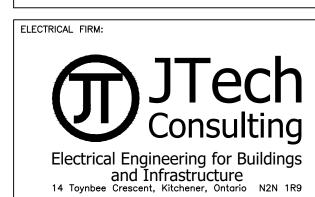

ENGINEERING SEAL:

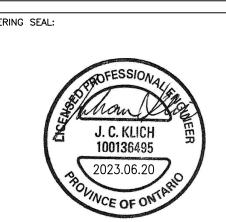

PROJECT NAME AND ADDRESS:


GUELPH/ERAMOSA SIGNAGÉ PROJECT (VARIOUS SITES)

DRAWING TITLE:

ELECTRICAL PLANS 5141 WELLINGTON ROAD 27

PROJECT NO:	SHEET:
JT230012	
DATE: 2023.01.03	E-102
COALE	


1/32" = 1'-0"

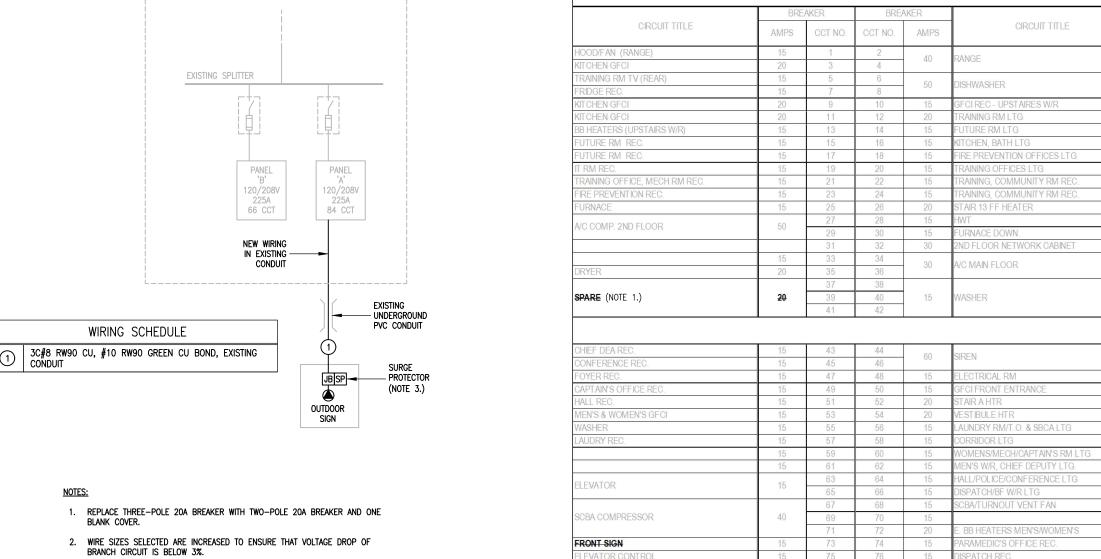

FED FROM:

<u>PANEL 'A' SCHEDULE — EXISTING</u>

MAKE/MODEL: SIEMENS TYPE S3

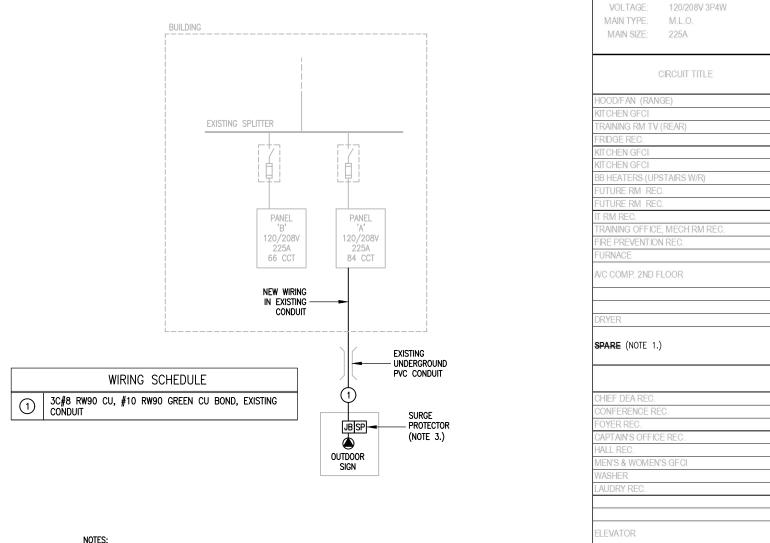



PROVIDE 208V SURGE PROTECTOR INSIDE OF SIGN ENCLOSURE. PROVIDE OCTAGONAL BOX INSIDE OF SIGN FOR MOUNTING AND WIRING OF SURGE PROTECTOR. STANDARD OF ACCEPTANCE: EATON SP1 SERIES.


ELECTRICAL POWER PLAN - RENOVATION


SCALE: N.T.S.

ELECTRICAL PART SINGLE LINE DIAGRAM

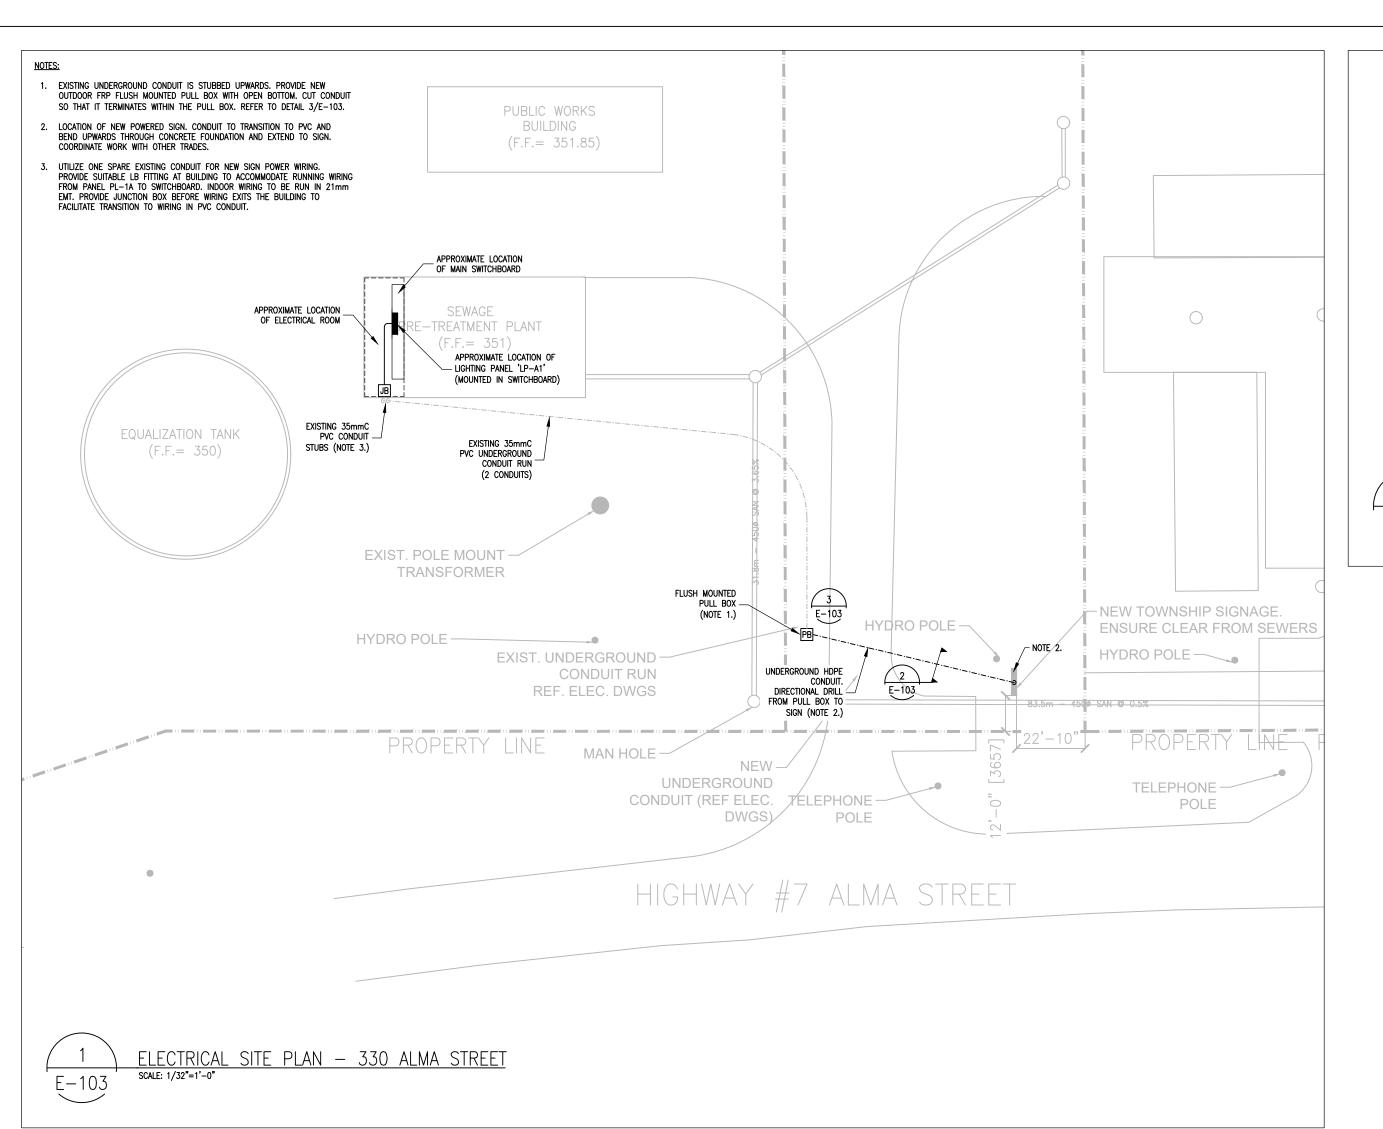

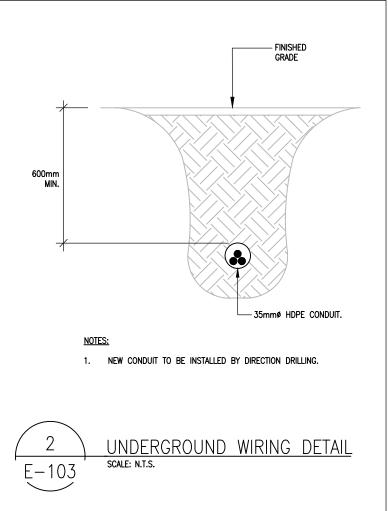

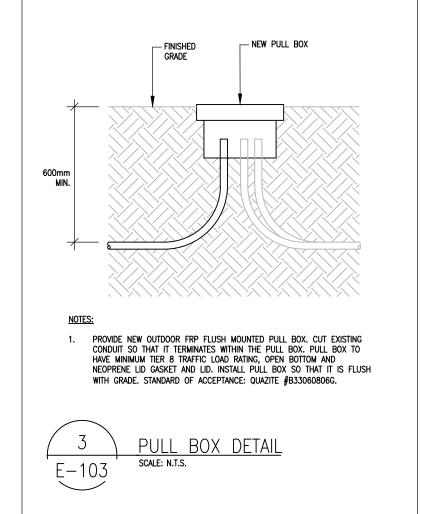

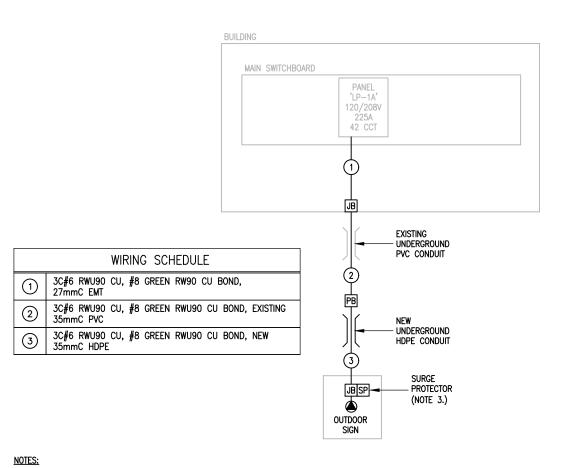

- 1. REPLACE TWO POLE 30A BREAKER WITH TWO POLE 20A BREAKER.

 2. WIRE SIZES SELECTED ARE INCREASED TO ENSURE THAT VOLTAGE DROP OF BRANCH CIRCUIT IS BELOW 3%.
- PROVIDE 208V SURGE PROTECTOR INSIDE OF SIGN ENCLOSURE. PROVIDE OCTAGONAL BOX INSIDE OF SIGN FOR MOUNTING AND WIRING OF SURGE PROTECTOR. STANDARD OF ACCEPTANCE: EATON SP1 SERIES.

ELECTRICAL PART SINGLE LINE DIAGRAM

ELECTRICAL PANELBOARD SCHEDULE PANEL: LP-A1 LOCATION: MAIN SWITCHBOARD								
VOLTAGE: 120/208V 3P4W				RECESSED				
MAIN TYPE: M.L.O.			D 1 1 10 111.	MAIN SWIT				
MAIN SIZE: 225A		MAKE	/MODEL:	EATON PRL	.1a			
	BRE	AKER	BREAKER					
CIRCUIT TITLE	AMPS	CCT NO.	CCT NO.	AMPS	CIRCUIT TITLE			
EXIT, EMERG LTG	15	1	2	15	EXHAUST FAN EF-2			
SUPPLY FAN SF-3	15	3	4	15	EXHAUST FAN EF-6			
EXHAUST FAN EF-1	15	5	6	20	MOTORIZED DAMPERS			
EXHAUST FAN EF-3	15	7	8	20	HOT WATER TANK			
TRAP SEAL PRIMER	15	9	10	20	HOT WAILK TANK			
EYE WASH STATION	15	11	12	30	(SPARE) (NOTE 1.)			
	15	13	14	30	(OF TITLE) (NOTE 1.)			
MAIN POWER FOR HVAC PANEL	15	15	16	15	(SPARE)			
RELECT RM REC.	15	17	18	15	UTILITY RM REC.			
ELEC RM LTG	15	19	20	15	CHEM RM LTG			
UTILITY RM LTG	15	21	22	15	BLOWER RM LTG			
PROCESS RM LTG	15	23	24	15	WET WELL 1 & 2 LTG			
EXTERIOR BLDG LTG	15	25	26	15	METER VALVE RM LTG			
RPU POWER	15	27	28	15	BLOWER AND UTIL RM REC.			
SUPPLY FAN SF-1	20	29	30	15	EQ TANK LTG			
·	20	31	32	15	PUMP 1 REC.			
EXHAUST FAN EF-5	15	33	34	15	PUMP 2 REC			
GENERATOR SHORE POWER	100	35	36	15				
OLINEIMI ON SHORE FOWER	100	37	38	15	(SPARE)			
SPARE)	15	39	40	15	PHOTO CELL, OUTDOOR LIGHTING & CTRL			
(SPARE)	15	41	42	15	(SPARE)			

PANEL	'LP-A1'	SCHEDULE	_	EXISTING	

PANEL:	LP-A1	LOCATION: MAIN SWITCHBOARD					
VOLTAGE:	120/208V 3P4W		MC				
MAIN TYPE:	M.L.O.		FE	D FROM:	MAIN SWIT	CHBOARD	
MAIN SIZE:	225A		MAKE	/MODEL:	EATON PRI	L1a	
		BRE	AKER	BREAKER			
(CIRCUIT TITLE	AMPS	CCT NO.	CCT NO.	AMPS	CIRCUIT TITLE	
XIT, EMERG LTC	3	15	1	2	15	EXHAUST FAN EF-2	
SUPPLY FAN SF-3	3	15	3	4	15	EXHAUST FAN EF-6	
XHAUST FAN EF		15	5	6	20	MOTORIZED DAMPERS (NOTE 1.)	
EXHAUST FAN EF	-3	15	7	8	20	HOT WATER TANK	
RAP SEAL PRIMI	ER	15	9	10	20	HOT WATER TANK	
YE WASH STATI	ON	15	11	12	20	OUTDOOR SIGN POWER	
		15	13	14			
1AIN POWER FO	C. C	15	15	16	15	(SPARE)	
RELECT RM REC		15	17	18	15	UTILITY RM REC.	
LEC RM LTG		15	19	20	15	CHEM RM LTG	
JTILITY RM LTG		15	21	22	15	BLOWER RM LTG	
ROCESS RM LT		15	23	24	15	WET WELL 1 & 2 LTG	
XTERIOR BLDG	LTG	15	25	26	15	METER VALVE RM LTG	
PU POWER		15	27	28	15	BLOWER AND UTIL RM REC.	
UPPLY FAN SF-1	1	20	29	30	15	EQ TANK LTG	
		20	31	32	15	PUMP 1 REC.	
XHAUST FAN EF	-5	15	33	34	15	PUMP 2 REC	
SENERATOR SHO	ORE POWER	100	35	36	15		
	ZILLI OWEN	100	37	38	15	(SPARE)	
SPARE)		15	39	40	15	PHOTO CELL, OUTDOOR LIGHTING & CTRL	
SPARE)	•	15	41	42	15	(SPARE)	


<u>PANEL 'LP-A1' SCHEDULE - REVISED</u>



	10	71	72	10	(OI / U(L)	
	, D v	1, 00		_		
PANEL	IPHA	1 50	HFI)[]]	r —	RFVISFD	

GENERAL NOTES

- DO NOT RELY UPON INFORMATION SHOWN ON THIS DRAWING FOR CONSTRUCTION UNLESS IT STATES BELOW THE SHEET HAS BEEN SPECIFICALLY ISSUED FOR THAT PURPOSE AND THE SHEET HAS BEEN STAMPED AND SIGNED.
- 2. DO NOT SCALE FROM DRAWINGS. PORTIONS OF DRAWINGS MAY NOT BE DRAWN TO
- VERIFY ALL DIMENSIONS ON SITE BEFORE PROCEEDING WITH THE WORK.
 COPYRIGHT 2023 JTECH CONSULTING.

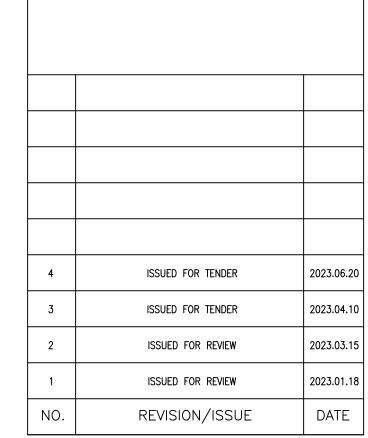


ARCHITECTURAL FIRM:



ELECTRICAL FIRM: TO JTech Consulting Electrical Engineering for Buildings and Infrastructure 14 Toynbee Crescent, Kitchener, Ontario N2N 1R9

ENGINEERING SEAL:

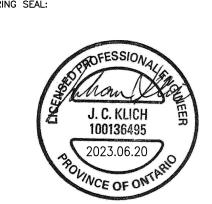


PROJECT NAME AND ADDRESS:


GUELPH/ERAMOSA SIGNAGE PROJECT (VARIOUS SITES)


DRAWING TITLE:


ELECTRICAL PLANS 330 ALMA STREET


PROJECT NO:	SHEET:
JT230012	
DATE: 2023.01.03	= 103
SCALE: $1/32" = 1'-0"$	

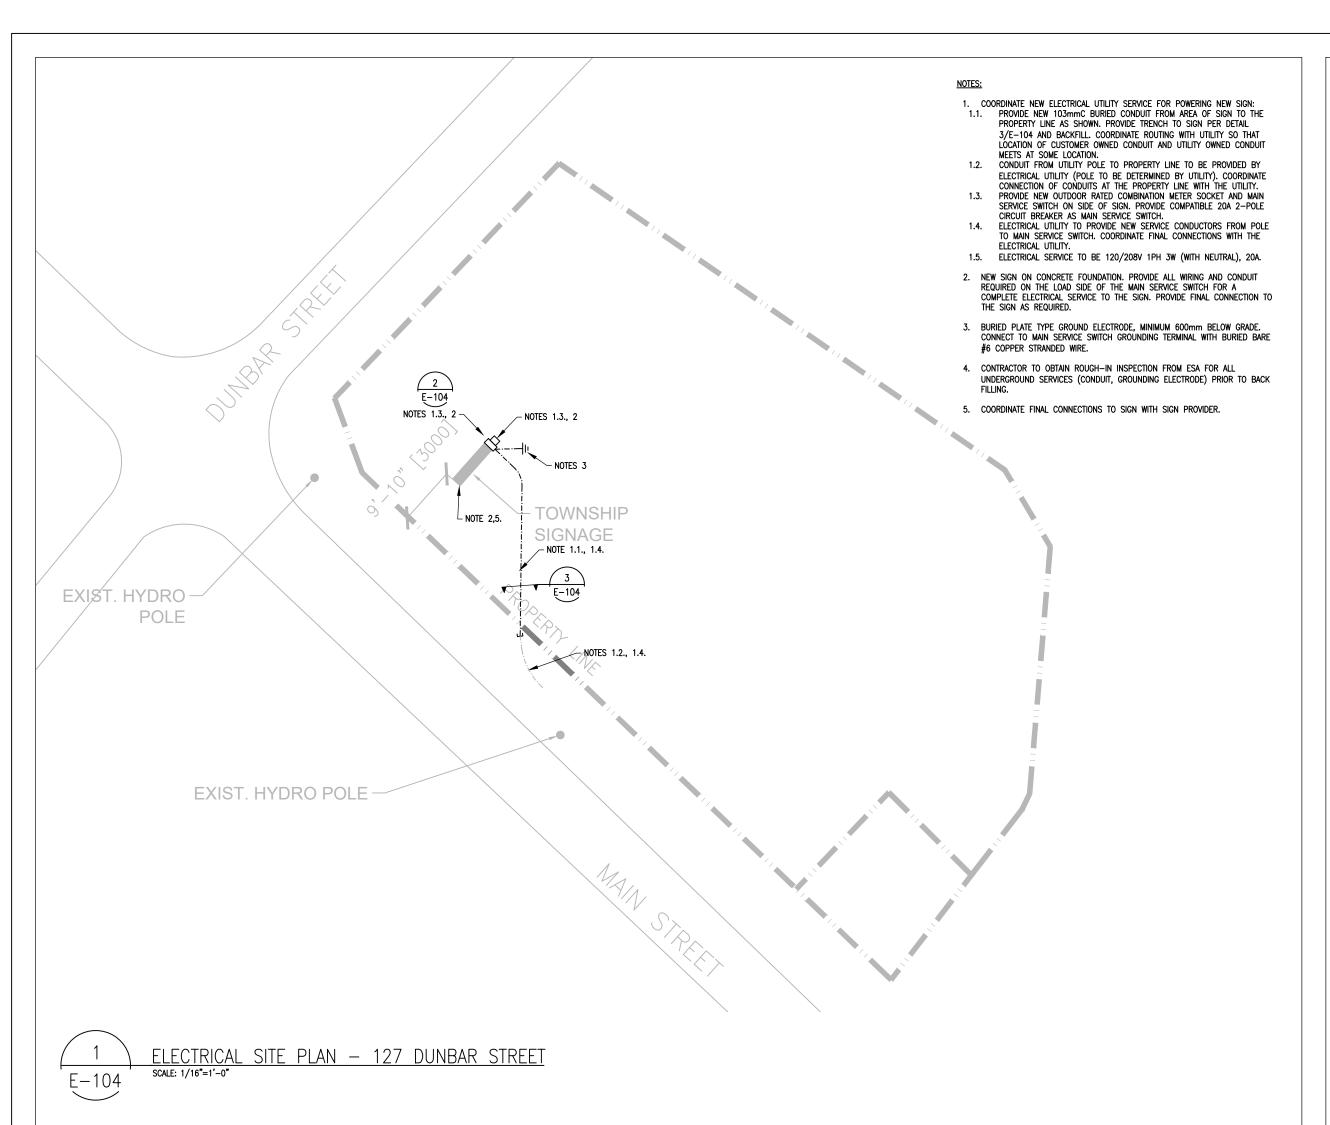

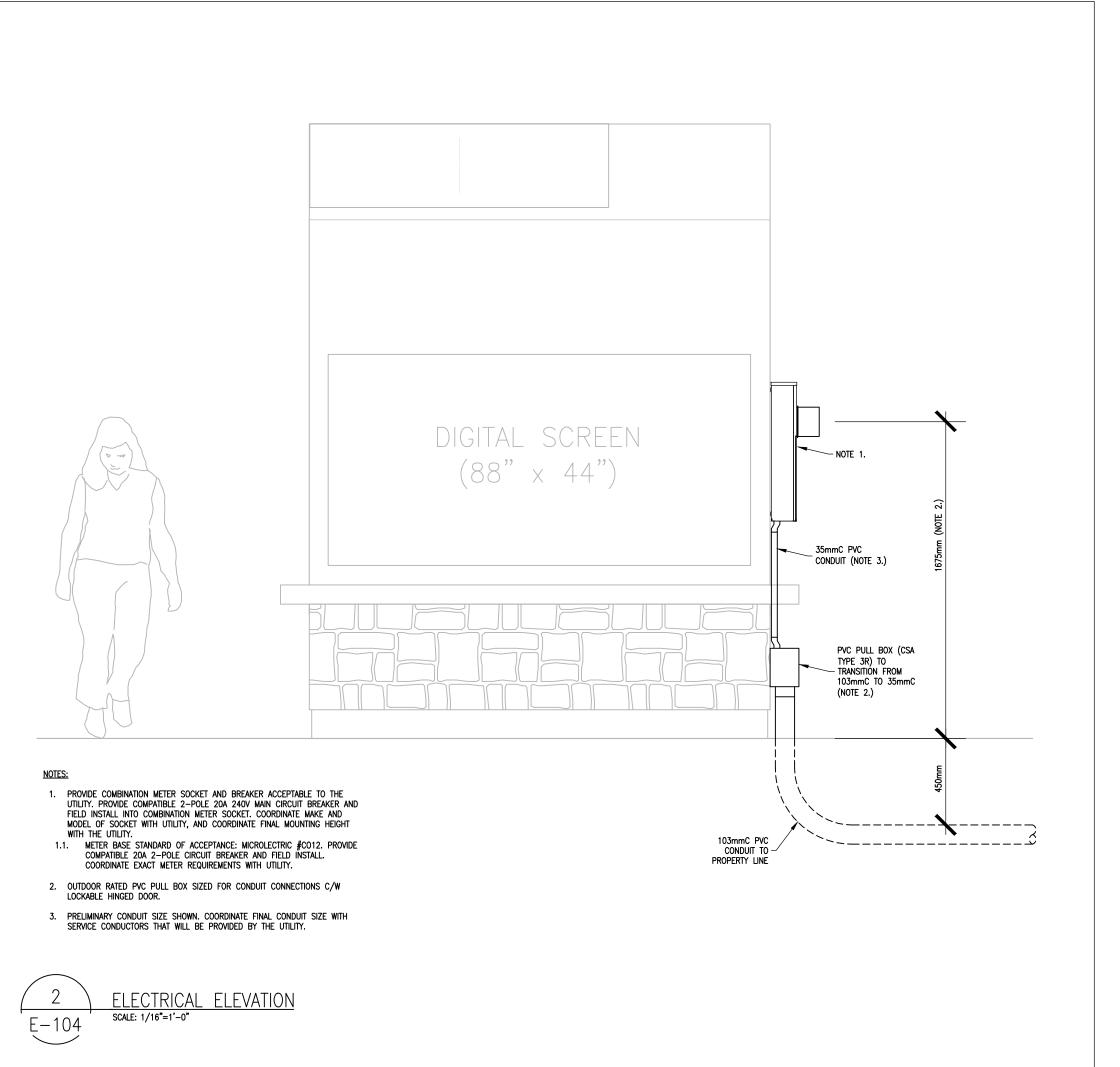

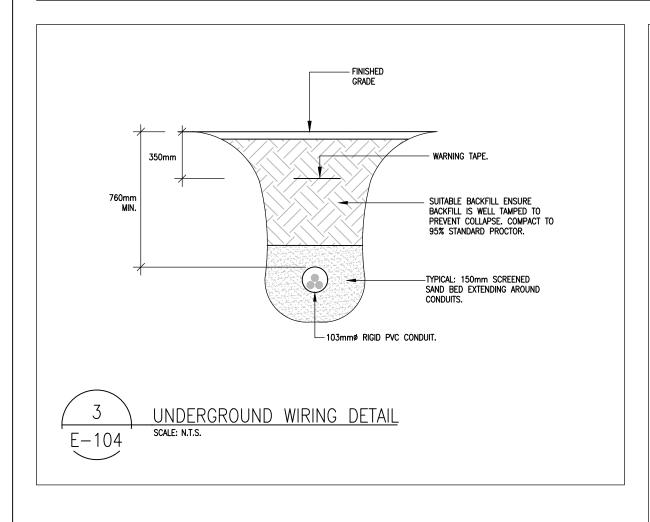

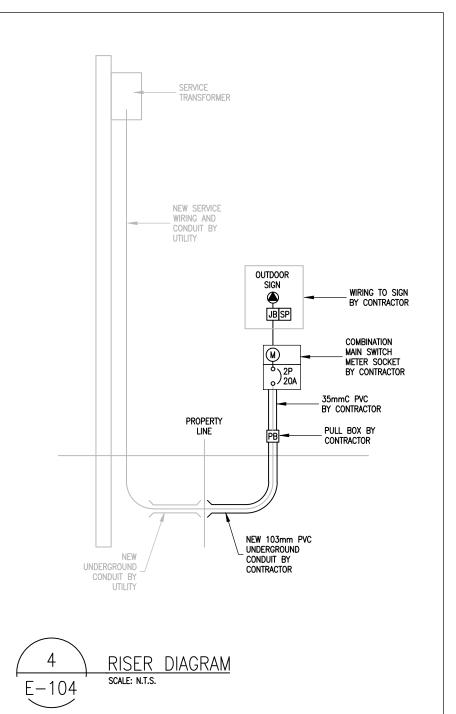

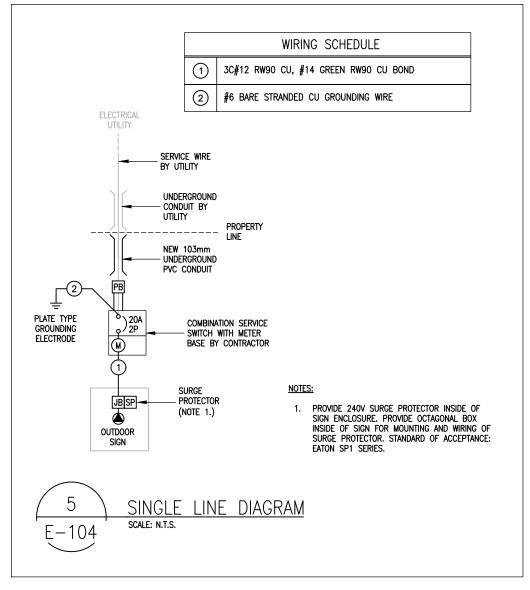


GENERAL NOTES

- DO NOT RELY UPON INFORMATION SHOWN ON THIS DRAWING FOR CONSTRUCTION UNLESS IT STATES BELOW THE SHEET HAS BEEN SPECIFICALLY ISSUED FOR THAT PURPOSE AND THE SHEET HAS BEEN STAMPED AND SIGNED.
- 2. DO NOT SCALE FROM DRAWINGS. PORTIONS OF DRAWINGS MAY NOT BE DRAWN TO
- 3. VERIFY ALL DIMENSIONS ON SITE BEFORE PROCEEDING WITH THE WORK. 4. COPYRIGHT 2023 JTECH CONSULTING.

2023.06.20 ISSUED FOR TENDER 2023.04.10 ISSUED FOR TENDER 2023.03.15 ISSUED FOR REVIEW 2023.01.18 ISSUED FOR REVIEW DATE REVISION/ISSUE





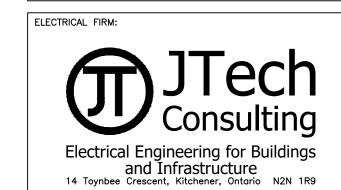

ENGINEERING SEAL:



PROJECT NAME AND ADDRESS:

GUELPH/ERAMOSA SIGNAGÉ PROJECT (VARIOUS SITES)

DRAWING TITLE:

ELECTRICAL PLANS 127 DUNBAR STREET

PROJECT NO:	SHEET:
JT230012	
DATE: 2023.01.03	= 104
SCALE: 1/16" = 1'-0"	

